


Notes:  
 All dimensions to be checked prior to build.  
 Levels to be checked on site prior to construction and full topographical survey needs to be done prior to build.  
 Drainage survey needs to be done prior to build. All drainage to be connected to existing.  
 We do not accept liability for any deviations from our drawings or specifications.  
 All structural elements to be checked by structural engineer.  
 All mechanical and electrical elements to be confirmed and checked by plumber and electrician prior to build.  
 All dimensions must be checked on site.  
 Levels to be checked on site prior to construction.  
 We do not accept liability for any deviations from our drawings or specifications.  
 All structural elements to be checked by engineer or contractor.

KEY	
	RAINWATER PIPE
	GULLY
	DIRECTION OF ROOF SLOPE
	INSPECTION CHAMBER

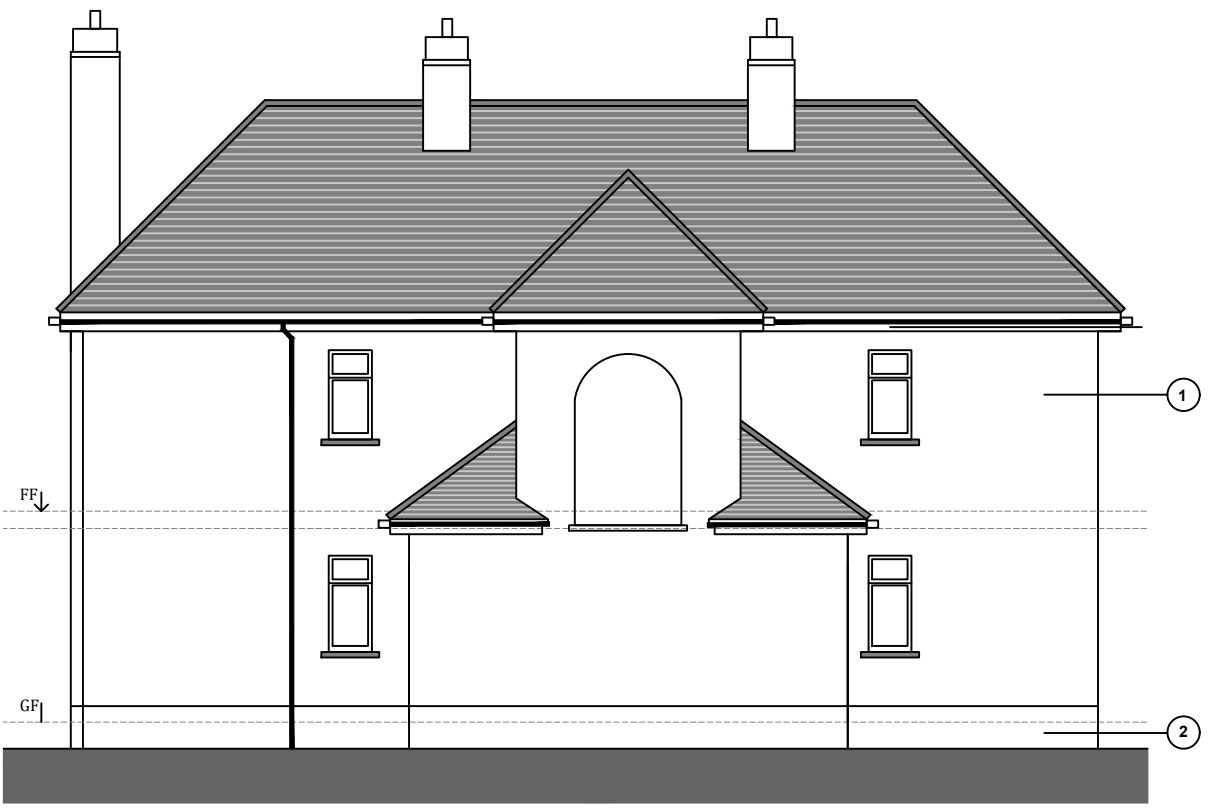

**Existing Front Elevation**  
 Scale 1:100




**Existing Rear Elevation**  
 Scale 1:100

**1 - Existing white through colour render**  
**2 - Existing brickwork finish**



**Existing Side Elevation**  
 Scale 1:100

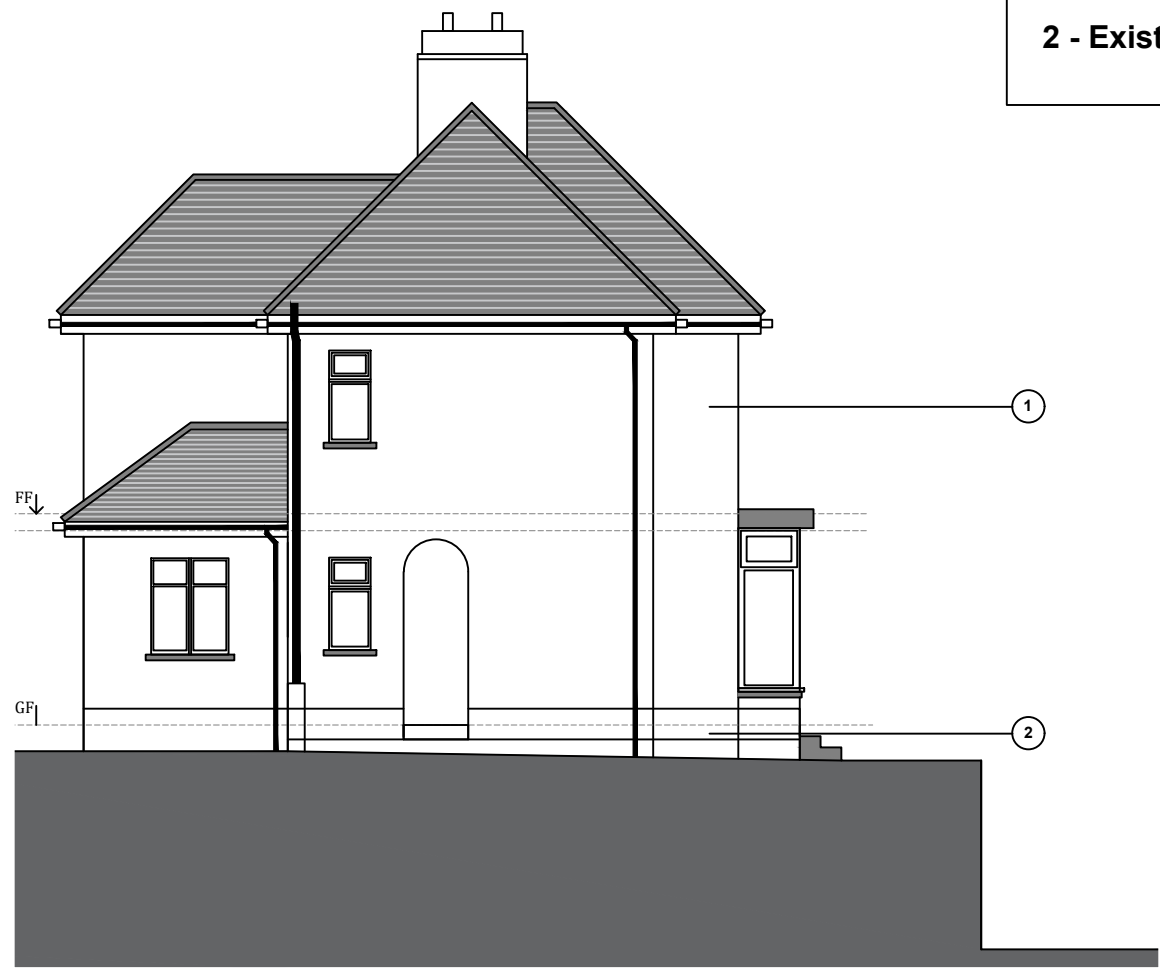

**Existing Side Elevation (1)**  
 Scale 1:100

C  
B  
A



<b>CLIENT</b>	-
<b>ADDRESS</b>	12 Cawley Lane, Heckmondwike
<b>PROJECT</b>	Proposed double storey extension Render to brick
<b>REVISION DATE</b>	08.09.25 <b>REVISION C</b>
<b>DRAWING ISSUE</b>	Full Planning
<b>DRAWN BY</b>	- <b>CHECKED BY</b>
<b>SCALE</b>	SEE DWG @A3
<b>DRAWING NO.</b>	004 - A3
<b>JOB NO.</b>	23-64

Scale 1:100



**TITLE** EXISTING ELEVATIONS