


PROJECT DESCRIPTION:	
SYSTEM SIZE	3.05KW DC STC
MODULE TYPE	(07) LONGI SOLAR LR5-54HTH-435M 435W

INDEX SHEET	
A.00	SITE PLAN
A.01	LAYOUT PLAN
S.00	FRAMING DETAILS
D.00-D01	SPECIFICATION SHEETS



C6 SPECTRUM
BUSINESS ESTATE
ANTHONY'S WAY,
ROCHESTER, KENT
ME2 4NP

PRO. DATE	16/09/2024
DESIGN BY	DR
CHECKED BY	JD

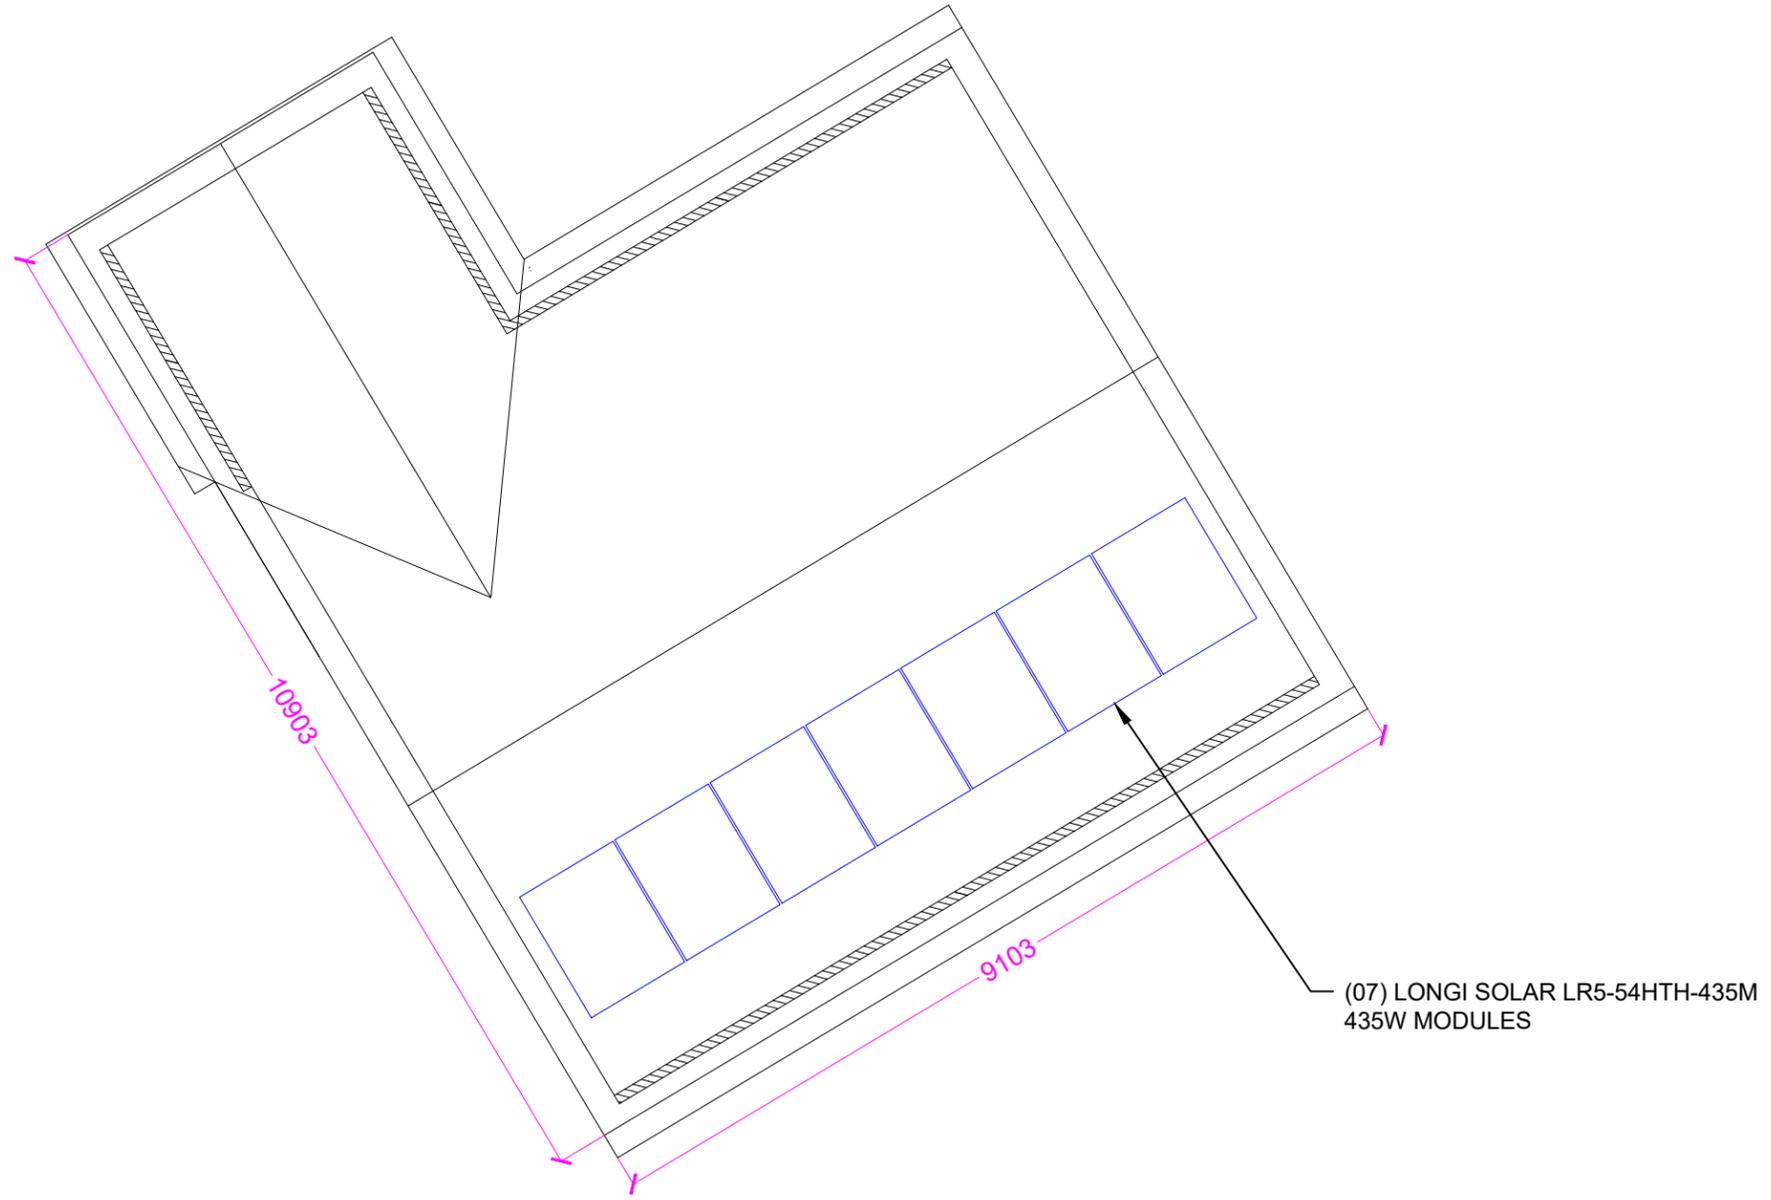

PROJECT NAME

WHITEHALL ROAD
(THE CHELTENHAM)

SHEET NAME

SITE PLAN

SHEET SIZE

ANSI B
279 X 432

SHEET NUMBER


A.00



1 SITE PLAN
SCALE: 1:75

MODULES AREA & ROOF AREA CALC'S

# OF MODULES	MODULES AREA (Sq. Meter)	ROOF AREA (Sq. Meter)	ROOF AREA COVERED BY MODULES (%)
07	13.65	88.90	15.35

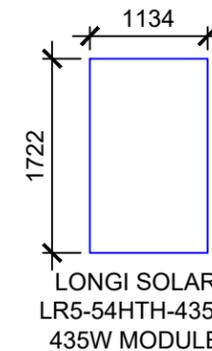

C6 SPECTRUM
BUSINESS ESTATE
ANTHONY'S WAY,
ROCHESTER, KENT
ME2 4NP

PRO. DATE	16/09/2024
DESIGN BY	DR
CHECKED BY	JD

PROJECT NAME

WHITEHALL ROAD
(THE CHELTENHAM)

SHEET NAME


LAYOUT PLAN

SHEET SIZE

ANSI B
279 X 432

SHEET NUMBER

A.01

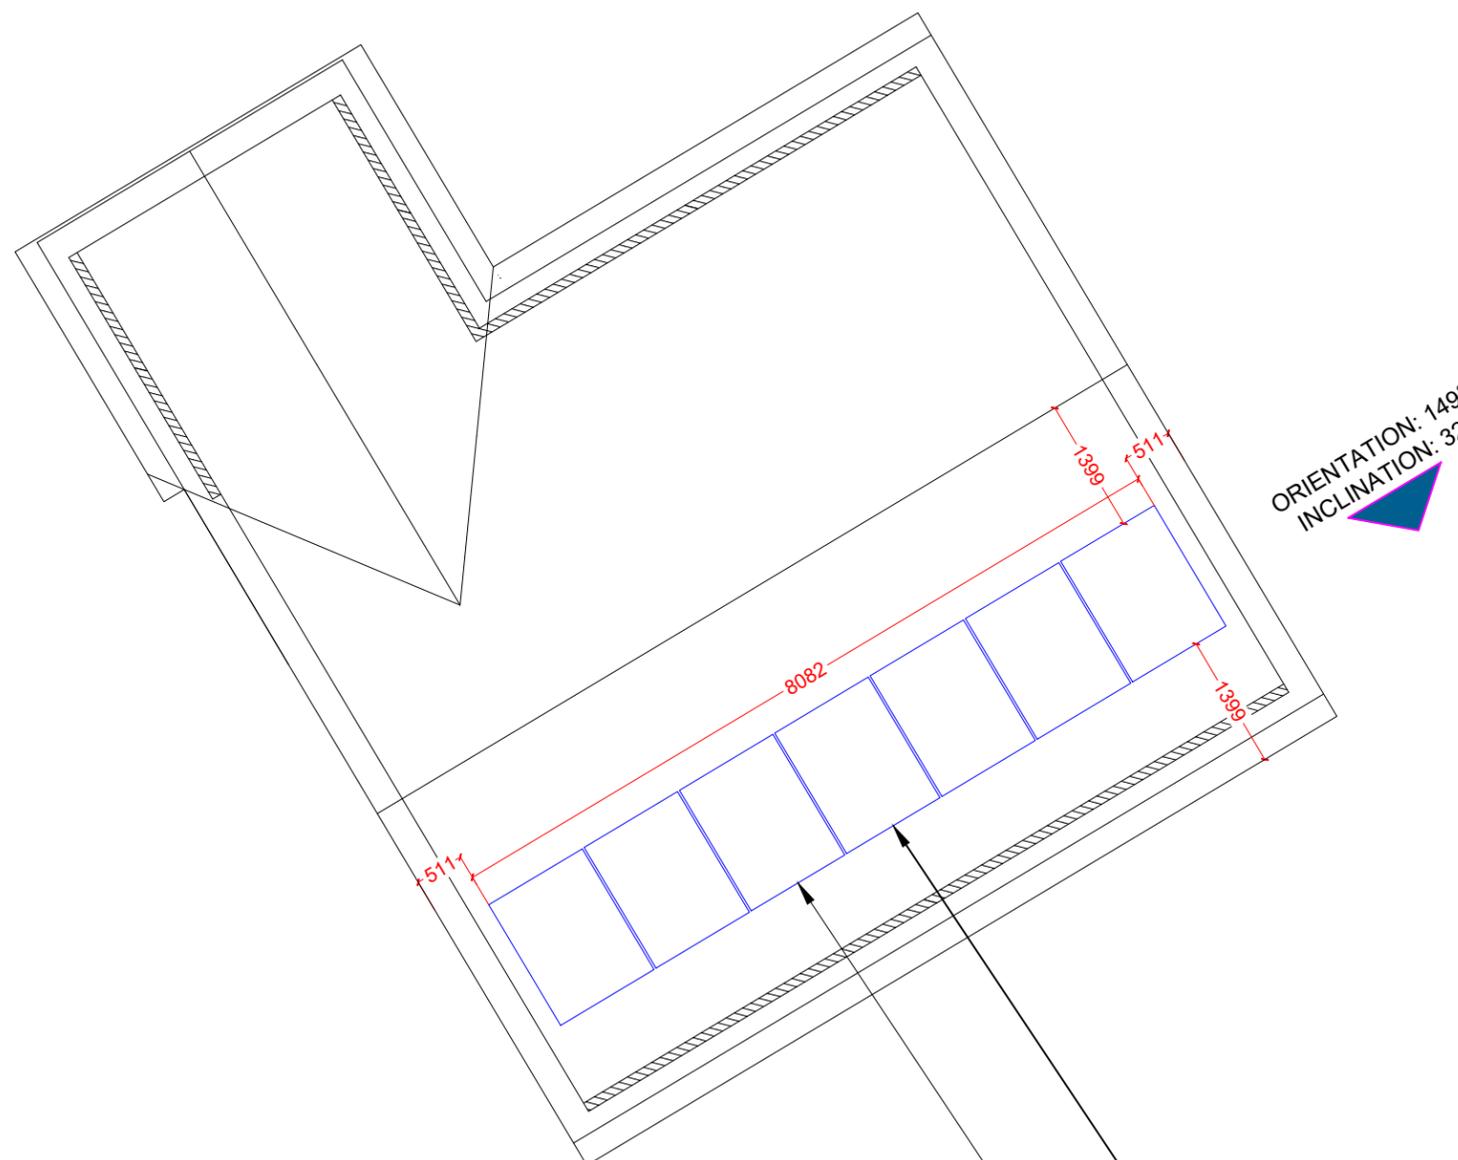

ORIENTATION: 149°
INCLINATION: 32°

(07) LONGI SOLAR LR5-54HTH-435M
435W MODULES

GSE INTEGRATION KIT
ATTACHMENT (TYP.)



1 LAYOUT PLAN
SCALE: 1:75

C6 SPECTRUM
BUSINESS ESTATE
ANTHONY'S WAY,
ROCHESTER, KENT
ME2 4NP

PRO. DATE	16/09/2024
DESIGN BY	DR
CHECKED BY	JD

PROJECT NAME

WHITEHALL ROAD
(THE CHELTENHAM)

SHEET NAME


FRAMING
DETAILS

SHEET SIZE

ANSI B
279 X 432

SHEET NUMBER

S.00

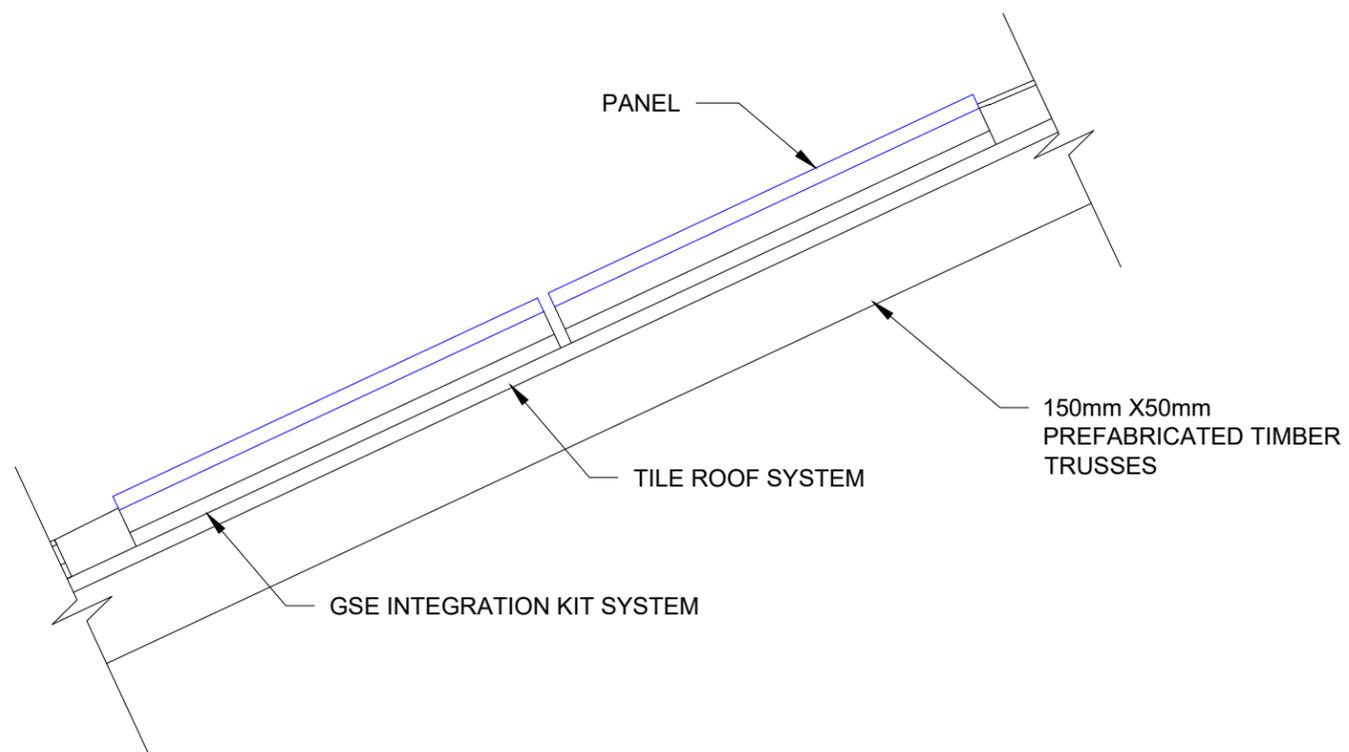

ATTACHMENT DETAILS

1

SCALE: NTS



ENLARGED VIEW

2

SCALE: NTS

Hi-MO 6
Scientists

LR5-54HTH 435~450M

- Suitable for distributed projects
- Excellent outdoor power generation performance
- High module quality ensures long-term reliability

25 25-year Warranty for Materials and Processing

25 25-year Warranty for Extra Linear Power Output

Complete System and Product Certifications

IEC 61215, IEC 61730, UL 61730
ISO9001:2015: ISO Quality Management System
ISO14001: 2015: ISO Environment Management System
ISO45001: 2018: Occupational Health and Safety
IEC62941: Guideline for module design qualification and type approval

LONGI



Hi-MO 6

LR5-54HTH 435~450M


23.0%
MAX MODULE
EFFICIENCY

0~3%
POWER
TOLERANCE

<1.5%
FIRST YEAR
POWER DEGRADATION



0.40%
YEAR 2-25
POWER DEGRADATION

Additional Value

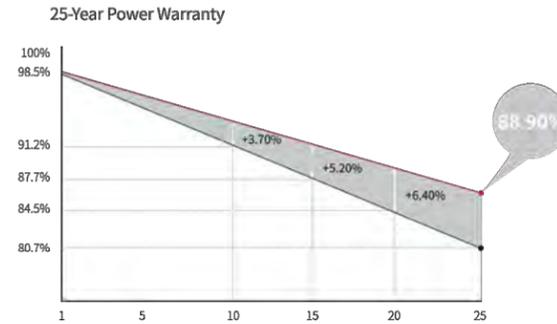

Mechanical Parameters

Cell Orientation	108 (6×18)
Junction Box	IP68, three diodes
Output Cable	4mm ² , ±1200mm length can be customized
Glass	Single glass, 3.2mm coated tempered glass
Frame	Anodized aluminum alloy frame
Weight	20.8kg
Dimension	1722×1134×30mm
Packaging	36pcs per pallet / 216pcs per 20' GP / 936pcs per 40' HC

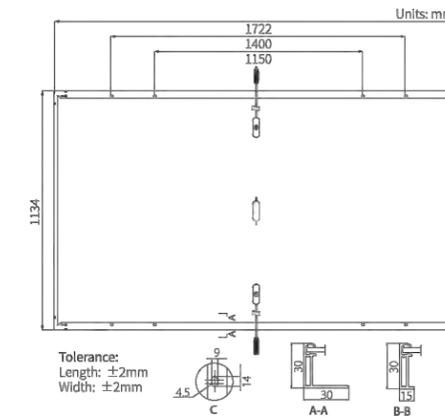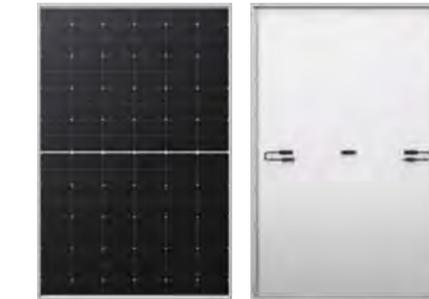

Electrical Characteristics

STC: AM1.5 1000W/m² 25°C NOCT: AM1.5 800W/m² 20°C 1m/s Test uncertainty for Pmax: ±3%

Module Type	LR5-54HTH-435M		LR5-54HTH-440M		LR5-54HTH-445M		LR5-54HTH-450M	
	STC	NOCT	STC	NOCT	STC	NOCT	STC	NOCT
Maximum Power (Pmax/W)	435	325	440	329	445	332	450	336
Open Circuit Voltage (Voc/V)	39.33	36.93	39.53	37.11	39.73	37.30	39.93	37.49
Short Circuit Current (Isc/A)	14.22	11.49	14.30	11.55	14.37	11.61	14.45	11.67
Voltage at Maximum Power (Vmp/V)	33.04	30.15	33.24	30.33	33.44	30.51	33.64	30.70
Current at Maximum Power (Imp/A)	13.17	10.78	13.24	10.85	13.31	10.90	13.38	10.95
Module Efficiency(%)	22.3		22.5		22.8		23.0	

Operating Parameters

Operational Temperature	-40°C ~ +85°C
Power Output Tolerance	0 ~ 3%
Voc and Isc Tolerance	±3%
Maximum System Voltage	DC1500V (IEC/UL)
Maximum Series Fuse Rating	25A
Nominal Operating Cell Temperature	45±2°C
Protection Class	Class II
Fire Rating	UL type 1 or 2 IEC Class C

Mechanical Loading

Front Side Maximum Static Loading	5400Pa
Rear Side Maximum Static Loading	2400Pa
Hailstone Test	25mm Hailstone at the speed of 23m/s

Temperature Ratings (STC)

Temperature Coefficient of Isc	+0.050%/°C
Temperature Coefficient of Voc	-0.230%/°C
Temperature Coefficient of Pmax	-0.290%/°C

LONGI

No.8369 Shangyuan Road, Xi'an Economic And Technological Development Zone, Xi'an, Shaanxi, China.
Web: www.longi.com

Specifications included in this datasheet are subject to change without notice. LONGI reserves the right of final interpretation. (20221020DraftV03) DG



C6 SPECTRUM
BUSINESS ESTATE
ANTHONY'S WAY,
ROCHESTER, KENT
ME2 4NP

PRO. DATE 16/09/2024
DESIGN BY DR
CHECKED BY JD

PROJECT NAME

WHITEHALL ROAD
(THE CHELTENHAM)

SHEET NAME

SPECIFICATION
SHEET

SHEET SIZE

ANSI B
279 X 432

SHEET NUMBER

D.00

GSE INTEGRATION KIT

In-Roof Integrated PV system for traditional Photovoltaic Panels

GSE INTEGRATION KIT

In-Roof Integrated PV system for traditional Photovoltaic Panels



C6 SPECTRUM
BUSINESS ESTATE
ANTHONY'S WAY,
ROCHESTER, KENT
ME2 4NP

PRO. DATE	16/09/2024
DESIGN BY	DR
CHECKED BY	JD

PROJECT NAME

WHITEHALL ROAD
(THE CHELTENHAM)

SHEET NAME

SPECIFICATION SHEET

SHEET SIZE

ANSI B
279 X 432

SHEET NUMBER

D.01



**"Fits 95%
of the PV Modules
on the Market"**

Simple, Quick, Aesthetic, Lightweight, Waterproof and Inexpensive


Developed by installers for installers, the GSE Integration Kit offers sizeable advantages :

- Easy to install
- Quick to mount : installation time is very valuable to professional installers and we kept that in mind when designing our kit (a 3kW System installed in 3 hours)
- Lightweight and easy to transport
- Completely Waterproof : ensures a complete watertightness of the PV System
- Flexible : achieve any desired configuration type (landscape, portrait, U-Shape, Pyramid etc), on any roof type
- Shock Resistant
- Climate Resistant (from -20C to 100C)
- Fits most existing PV modules
- 100% Recyclable
- Inexpensive : GSE integration kit is to date the most cost efficient In-Roof PV System on the market, making it ideal for roof retrofits and new construction.



Technical Specs

Available Sizes : (in mm)	From 1635 to 1680 / 982 to 993 (Portrait / Landscape) From 1635 to 1680 / 994 to 1002 (Portrait / Landscape) 1580 / 808 (Portrait / Landscape) 1575 / 1082 (Portrait / Landscape) 1559 / 1046 (Portrait / Landscape) 1575 / 1069 (Portrait / Landscape)
Color	SILVER / BLACK (100% Recyclable)
Material	PP – Aluminum – Stainless Steel (100% Recyclable)
Temperature Range	-20°C to 100°C (Vicat Softening Point: 148°C)
Slope	10° to 50°
Weight	2 to 3 kg / m ²
Warranty	10 Years

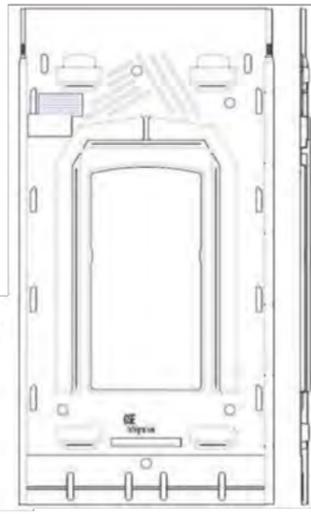

Our Certifications



GROUPE SOLUTION ENERGIE
155-159 rue du Dr Bauer. 93400 SAINT-OUEN
+33 1 70 32 08 00 / contact@gseintegration.com
www.gseintegration.com

www.gseintegration.com