



FRONT ELEVATION  
Scale 1:50 @ A1

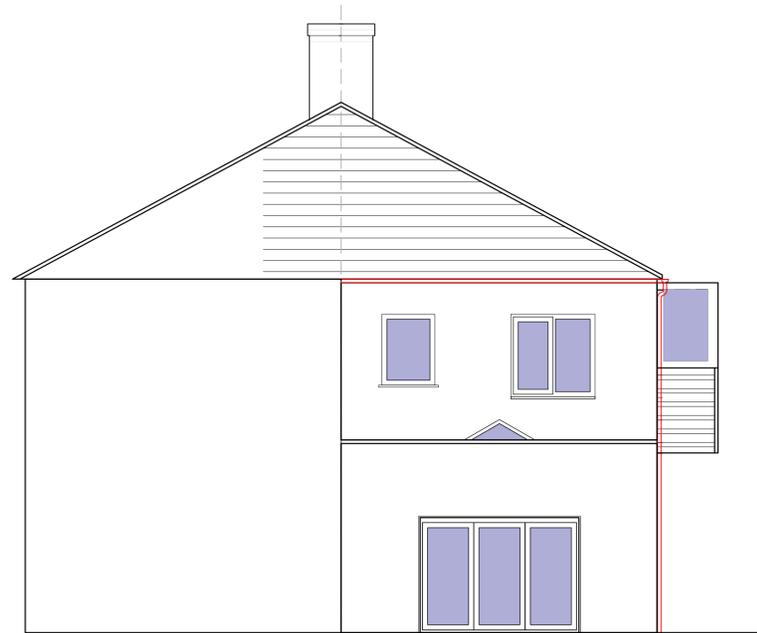

REAR ELEVATION  
Scale 1:50 @ A1



SIDE ELEVATION  
Scale 1:50 @ A1

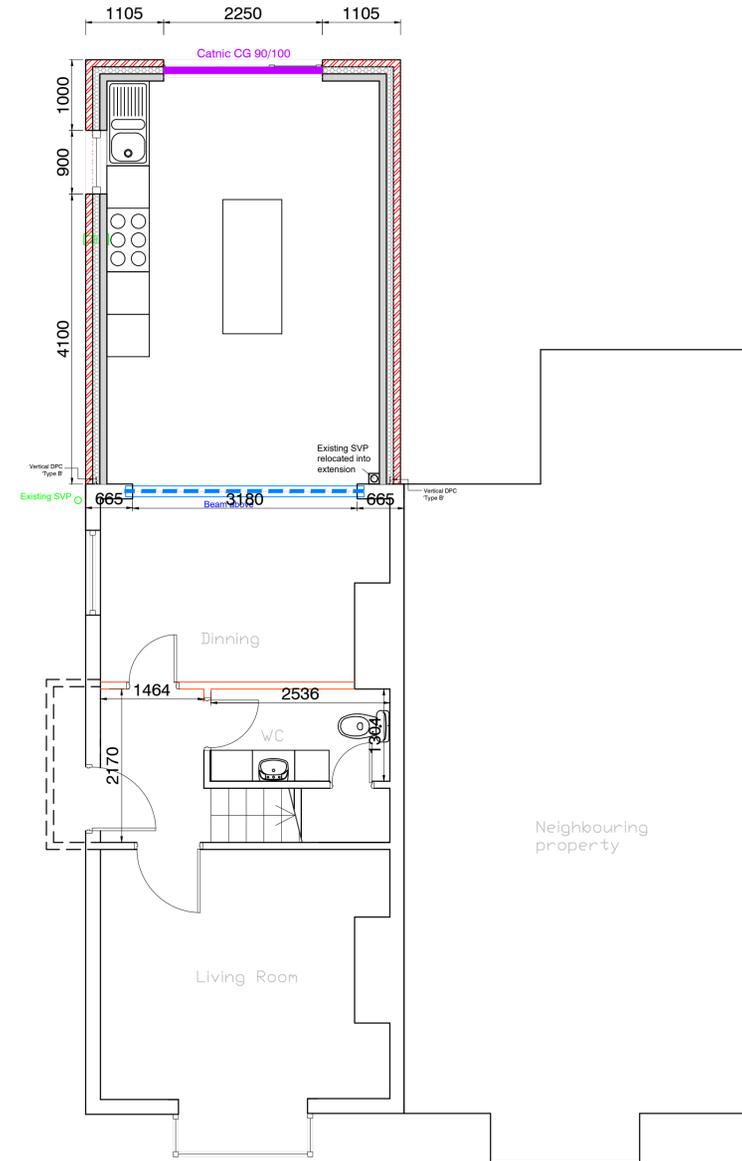

PROPOSED SITE PLAN  
Scale 1:50 @ A1

DO NOT SCALE FROM THIS DRAWING

GENERAL

1. These notes are intended to augment drawings and specifications. Where conflict of requirements exists the order of precedence shall be as shown in the specifications. Otherwise the strictest provision shall govern.
2. This drawing is to be read in conjunction with all other relevant Engineers and Architects drawings.
3. Drawings not to be scaled. All dimensions to be checked on site by the Contractor prior to the commencement of any work or shop drawing. Any discrepancies to be notified to the Architect & Engineer and further instructions obtained before work is commenced.
4. The structure is designed to be self-supporting and stable after the building is fully complete. It is the Contractors sole responsibility to determine the erection procedure and sequence and ensure that the building and its components are safe during erection. This includes the addition of whatever temporary bracing, guys or tie-downs which may be necessary, such material remaining the property of the Contractor upon completion.
5. Padstones as detailed

DRAWING REVISIONS

REV	DESCRIPTION	DATE	BY	CHK

CLIENT  
Ahmed Trog

PROJECT  
Proposed Extension and Alteration works at Existing Residential 45 Old Leeds Road

DRAWING TITLE  
Proposed Layout

DRAWING STATUS  
**FOR COMMENT**

SCALE	DATE	
1:50 @ A1	May-2025	
DRAWN BY	CHECKED BY	
JF	AT	
JOB NO.	DWG NO.	REV
0001	SK100	-