


New u-pvc patio doors to match existing providing access to rear garden area.

Proposed double storey side extension cavity wall construction consisting of outer leaf of random natural stone, insulated cavity and 100mm blockwork inner leaf.


Dashed line of existing external stone leaf to be carefully removed and re-used on proposed side extension works

New U-PVC door to match existing.

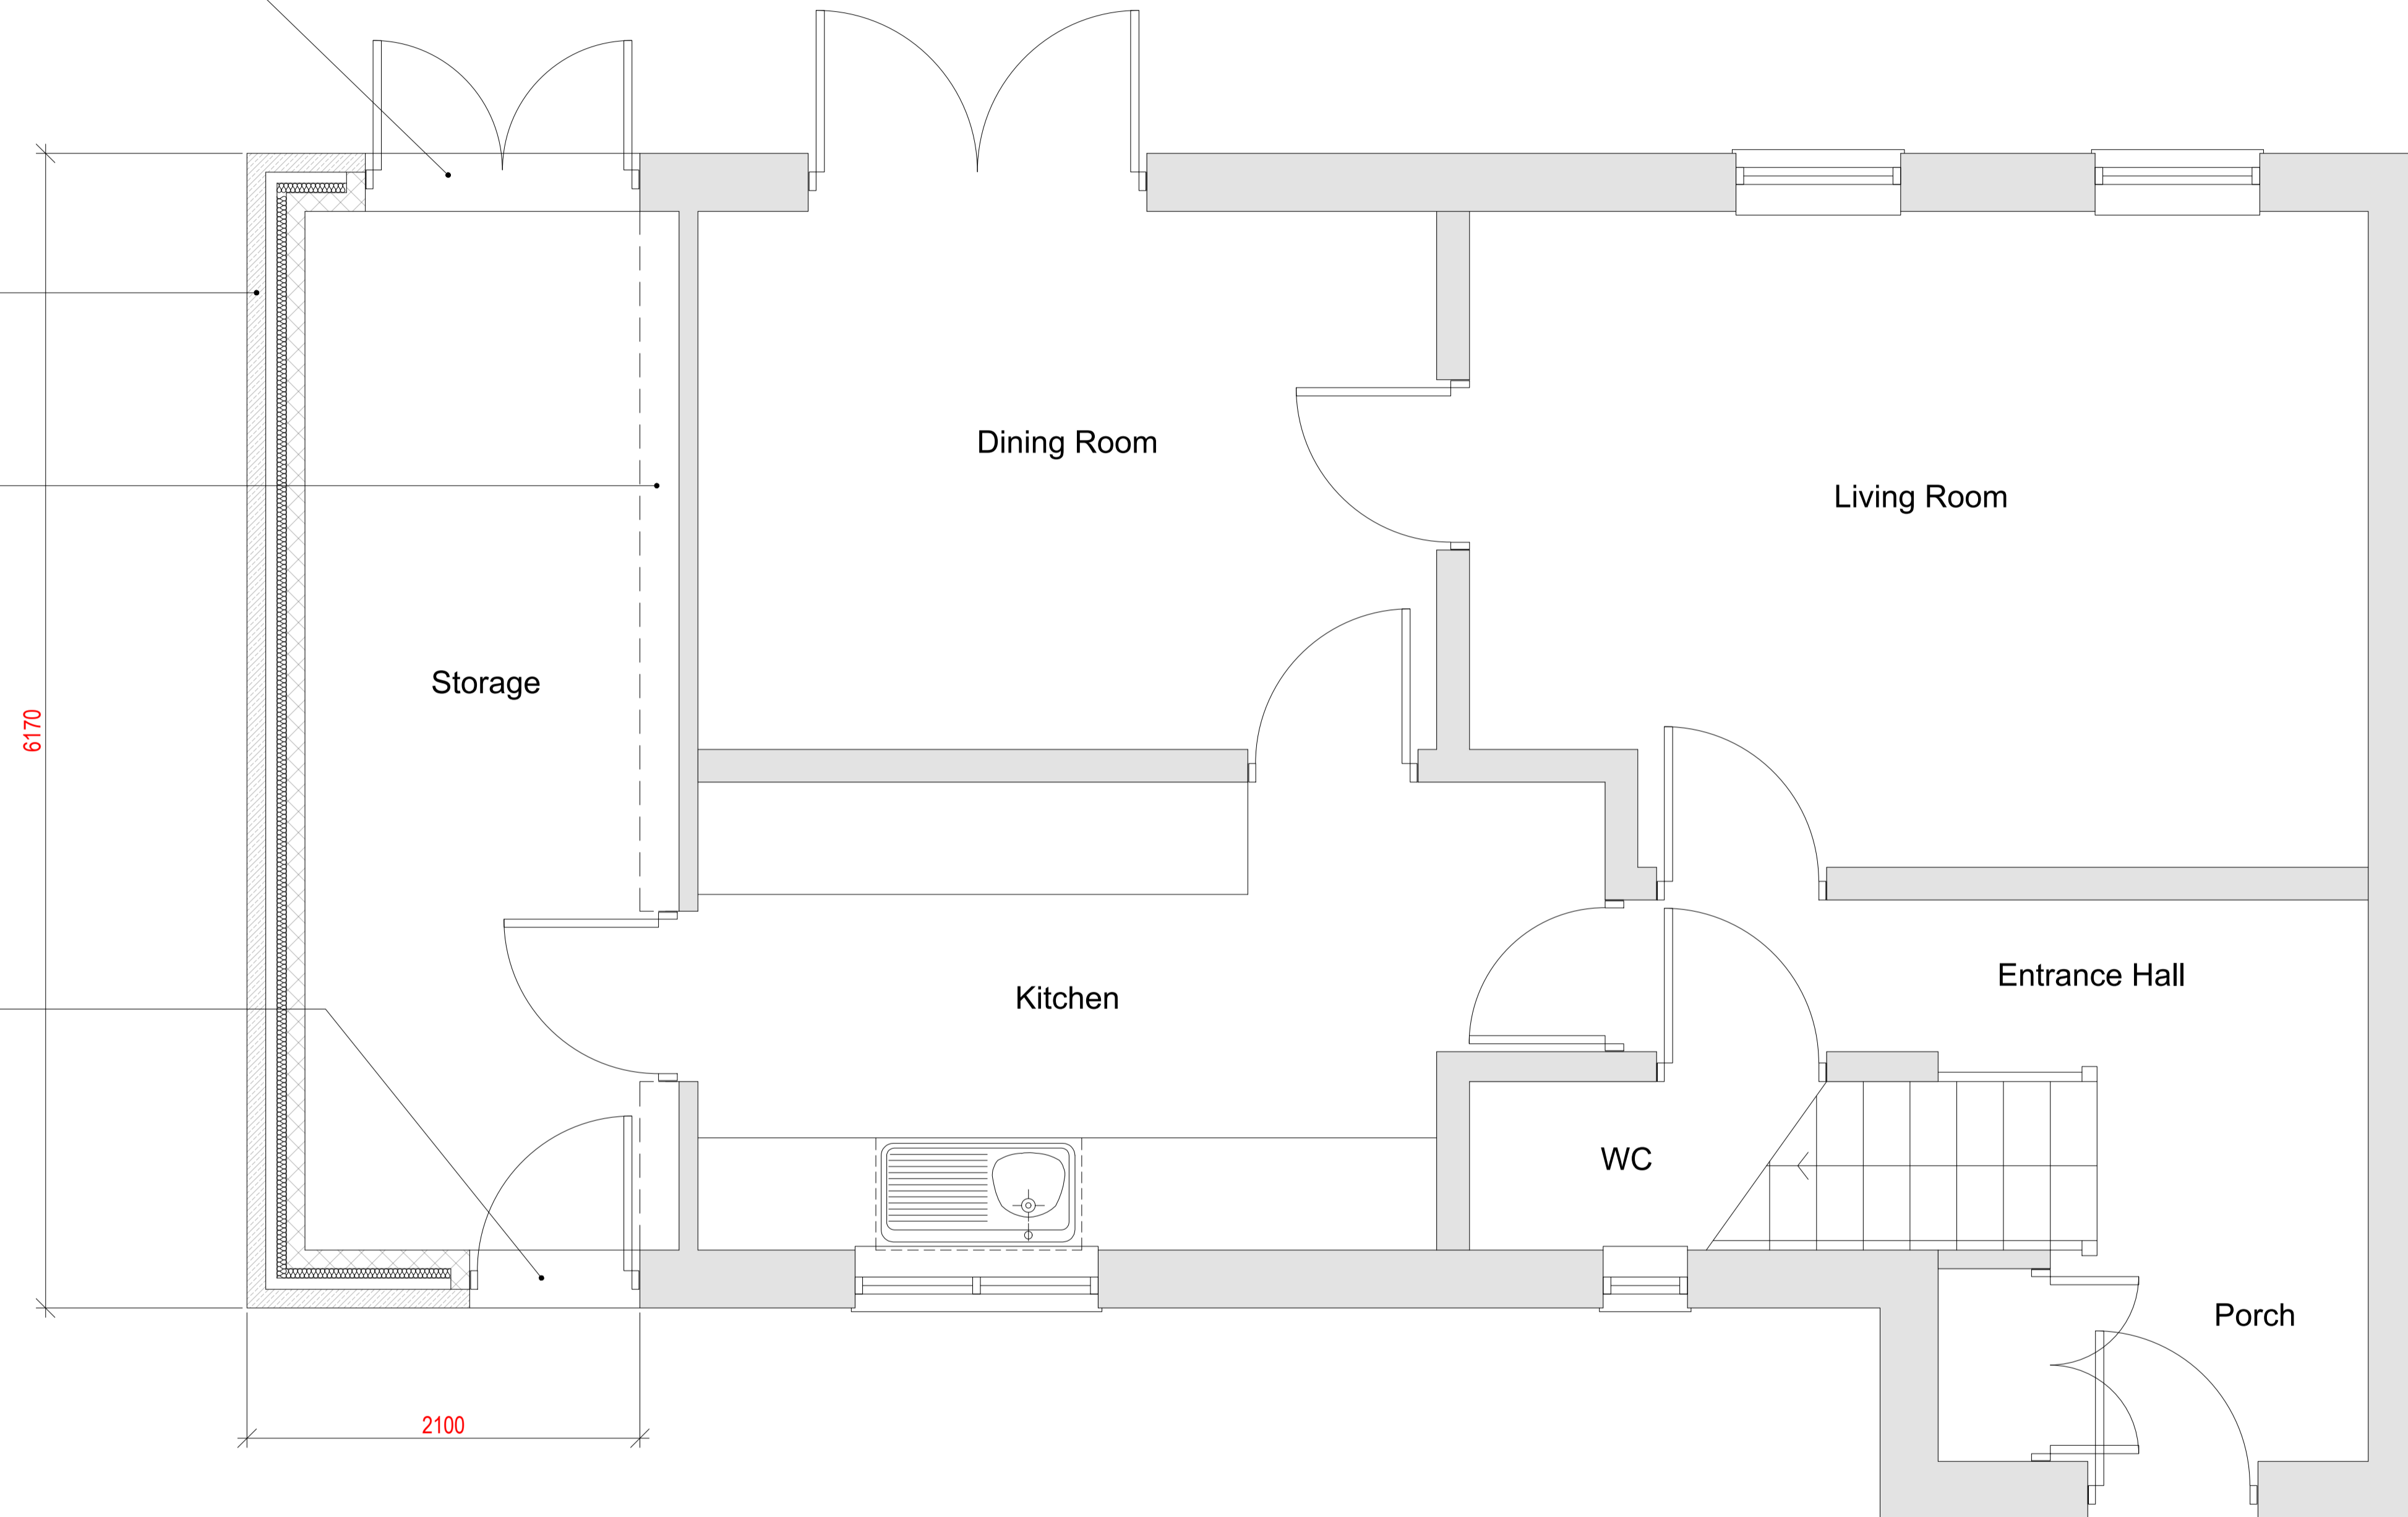

PROPOSED GROUND FLOOR PLAN  
1:25

PLANNING ISSUE

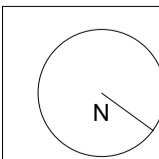

Notes:

- All dimensions are to be checked on site by the contractor and inform the architect of any discrepancies.
- The information contained on this drawing has been produced for planning purposes only and is not intended to be used as construction information.

Contractor must verify all dimensions on site before commencing any work or shop drawings. If this drawing exceeds the quantities taken in any way the Architects are to be informed before the work is initiated. Only figured dimensions to be taken from this drawing. Do not scale off this drawing. Drawings based on Ordnance Survey and / or existing record drawings - design and drawing content subject to Site Survey, Structural Survey, Site Investigations, Planning and Statutory Requirements and Approvals. Authorised reproduction from Ordnance Survey Map with permission of the Controller of Her Majesty's Stationery Office. Crown Copyright reserved. Urban Box Architects Ltd.

Rev. Des.

By

Date

Ch.

Status:

PLANNING

Client: MR & MRS BARLOW		Job No. 23,001
Project: 25 BISHOPS WAY, MELTHAM		
Title: PROPOSED GROUND FLOOR PLAN		
Date: 30.01.23	Scale: 1:25@A1	Checked By:
Drawing No: (00) 006	Drawn By: AN	Revision:

URBAN BOX