


NOTES:
Any errors or omissions to be reported to Code L6 immediately.
This drawing and design is the copyright of Code L6 and is not to be used for any purpose without their consent.



CROSS STREET

ORCHARD STREET

ROLEC EV/OLEV Home Car charge Point
The cable and circuitry ratings for the charging points shall be of adequate size to ensure a minimum continuous current demand of 16 Amps and a maximum demand of 32Amps. Located in garage.

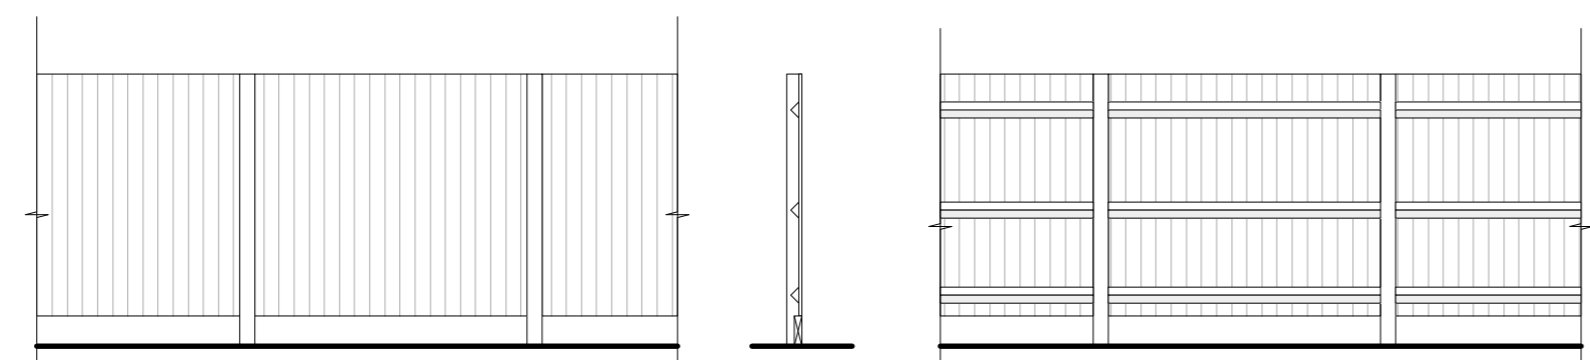


Boundary Type 01 1.8m High Close Bordered pressure treated timber Fence
Scale 1:50



Schwegler bat box at high level on the South Elevation.

Site/ Roof Plan As Proposed
Scale 1:100

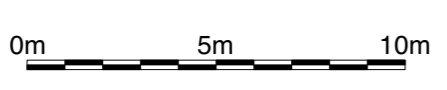

Code L6
Architects Ltd
No 2 Warehouse, The Wharf,
Sowerby Bridge,
HX6 2AG
T: 01422 648431
E: info@codeL6.com
W: www.CODEL6.com

Project:
50 Orchard Street,
Dewsbury,
WF12 9LH

Client:
Mr I Patel

Drawing:
Plans As Proposed

Date: 18/11/25
Scale: varies
Size: A1

Drawing Number:
25-047-06