


Existing Site Plan  
Scale 1:200

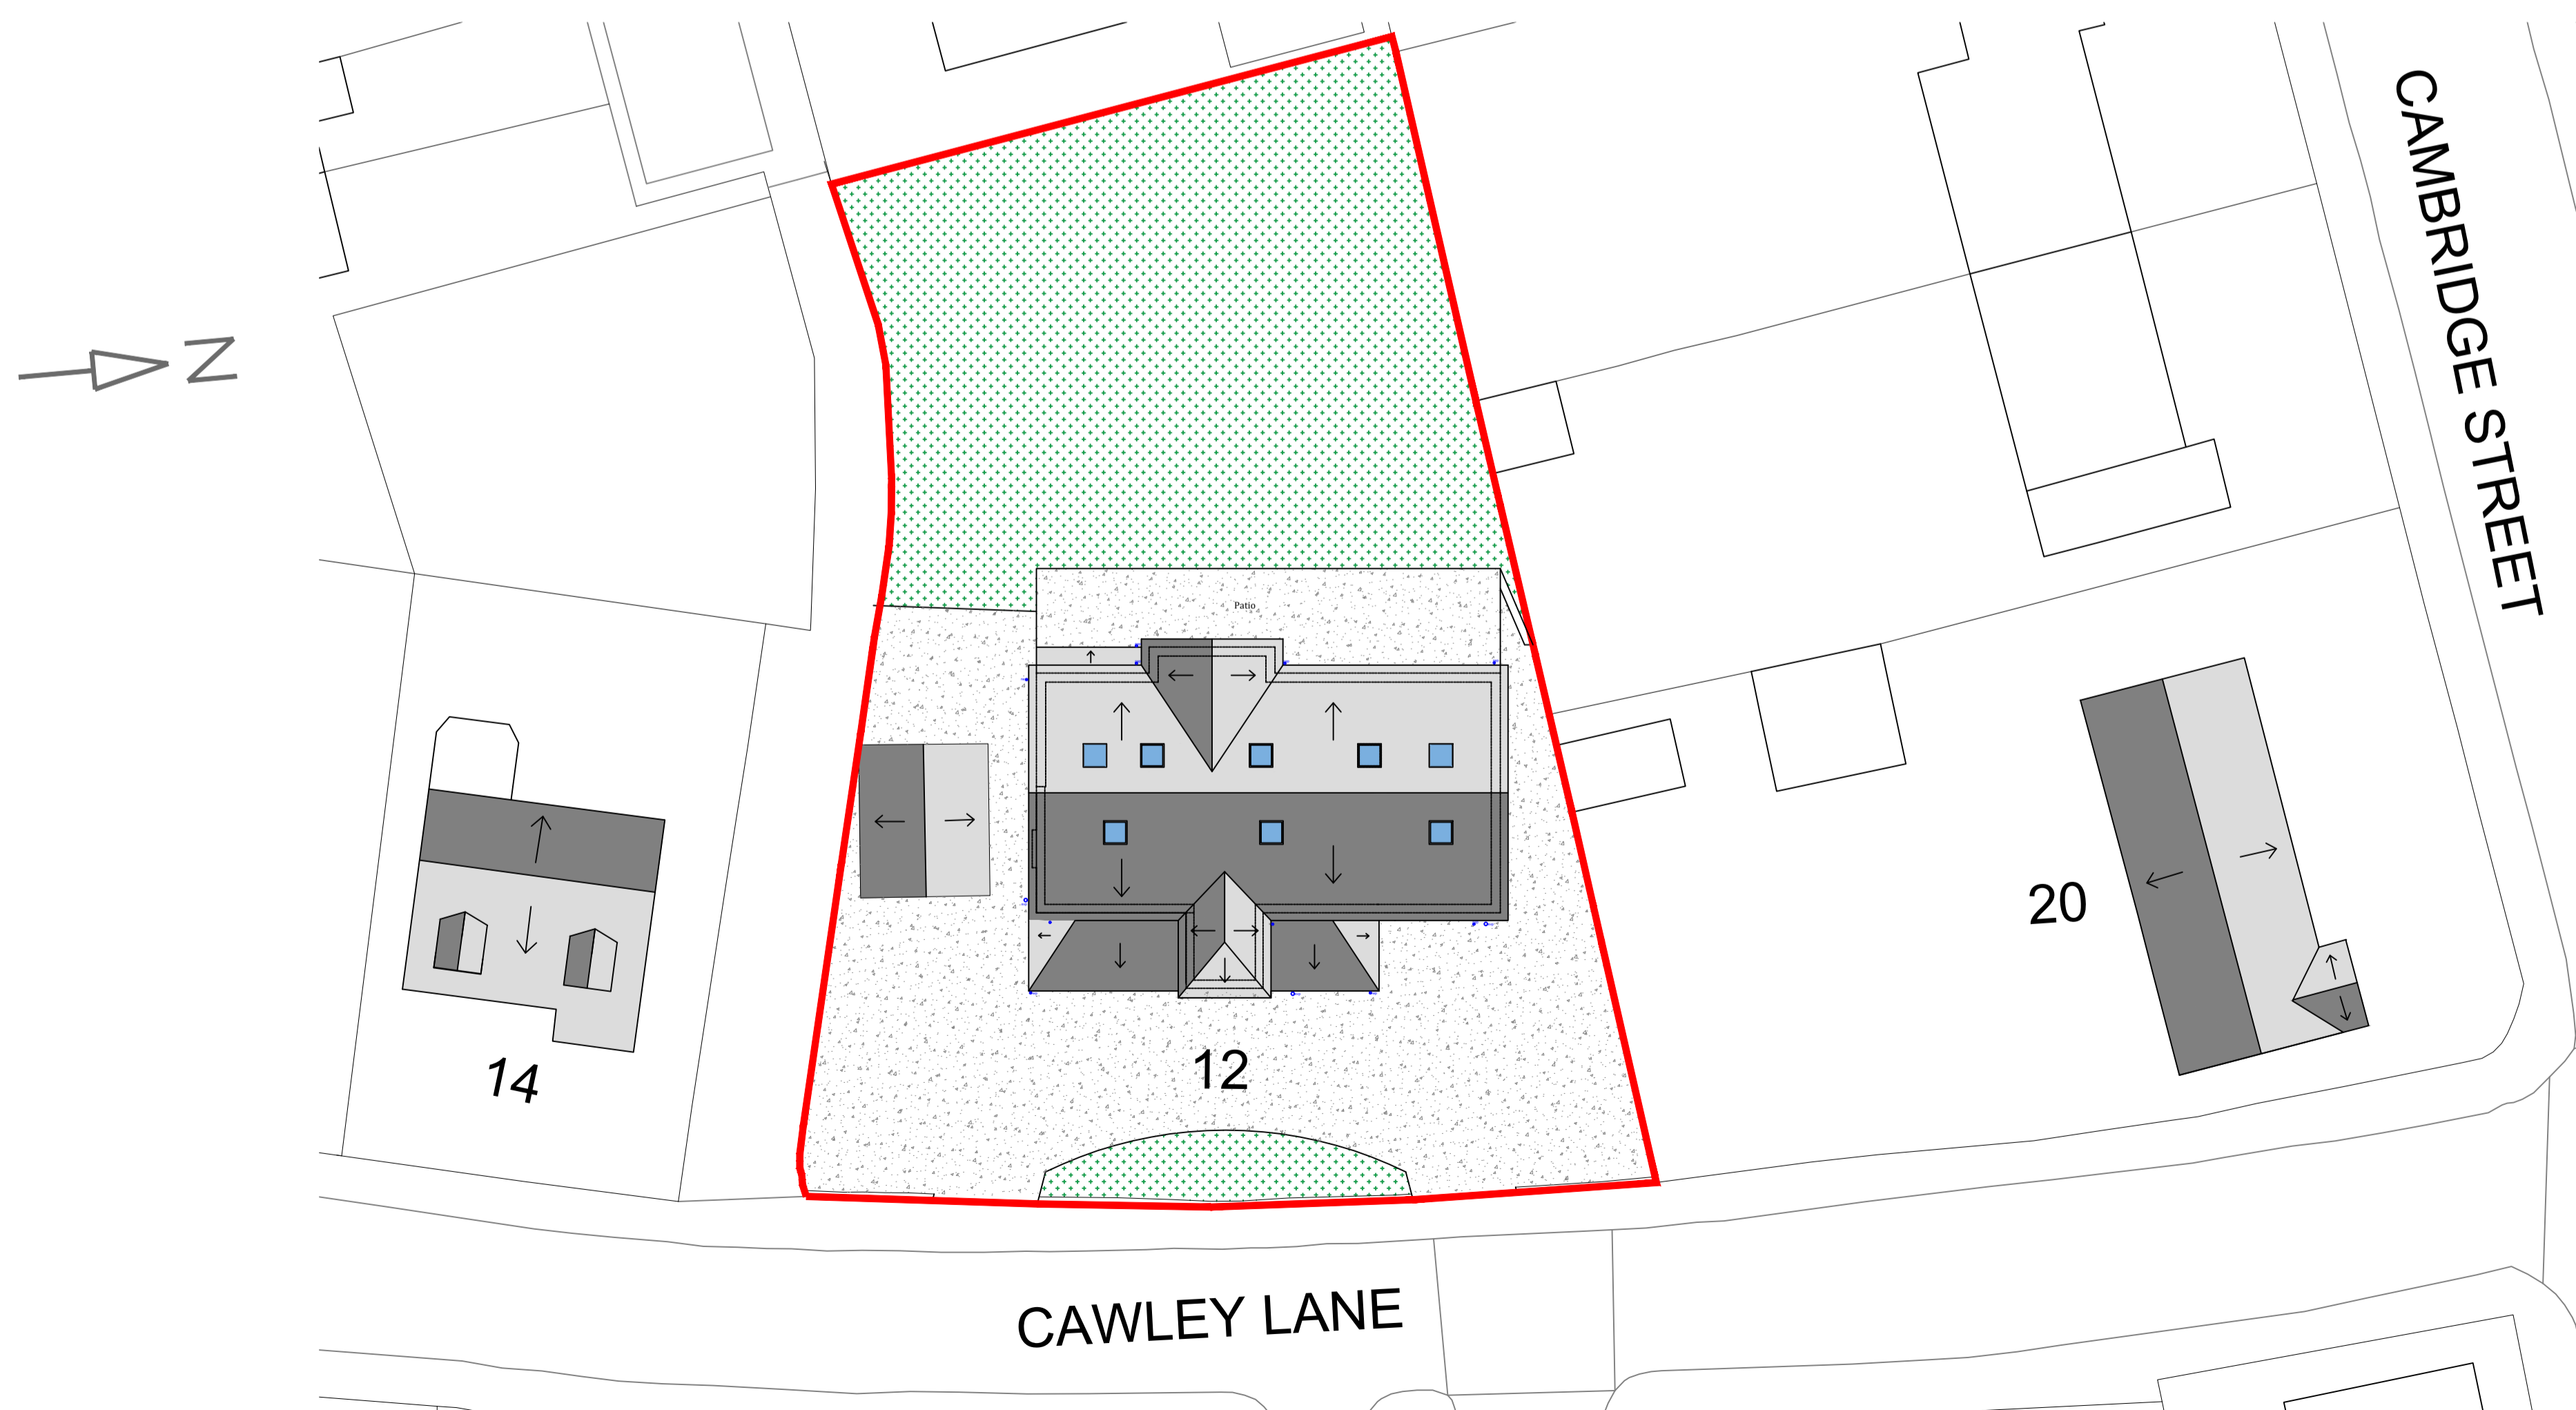

Proposed Site Plan  
Scale 1:200

**Notes:**  
 All dimensions to be checked prior to build.  
 Levels to be checked on site prior to construction and full topographical survey needs to be done prior to build.  
 Drainage survey needs to be done prior to build. All drainage to be connected to existing.  
 We do not accept liability for any deviations from our drawings or specifications.  
 All structural elements to be checked by structural engineer  
 All mechanical and electrical elements to be confirmed and checked by plumber and electrician prior to build.  
**All dimensions must be checked on site**  
**Levels to be checked on site prior to constructions**  
**We do not accept liability for any deviations from our drawings or specifications**  
**All structural elements to be checked by engineer or contractor.**

KEY	
	RAINWATER PIPE
	GULLY
	DIRECTION OF ROOF SLOPE
	INSPECTION CHAMBER

KEY  
 RED LINE BOUNDARY

B - Side extension now made flush with house including roof.  
 Front glazed extension extended 200mm



CLIENT	-
ADDRESS	Cawley Lane, Heckmondwike
PROJECT	Proposed double storey extension Render to brick
REVISION DATE	07.02.26 <b>REVISION B</b>
DRAWING ISSUE	
DRAWN BY	- <b>CHECKED BY</b> EM
SCALE	SEE DWG @A1
DRAWING NO.	002 - A1
JOB NO.	23-64

**TITLE** EXISTING & PROPOSED SITE/BLOCK PLAN

